




NORTH ELEVATION
(SCALE 1:200)

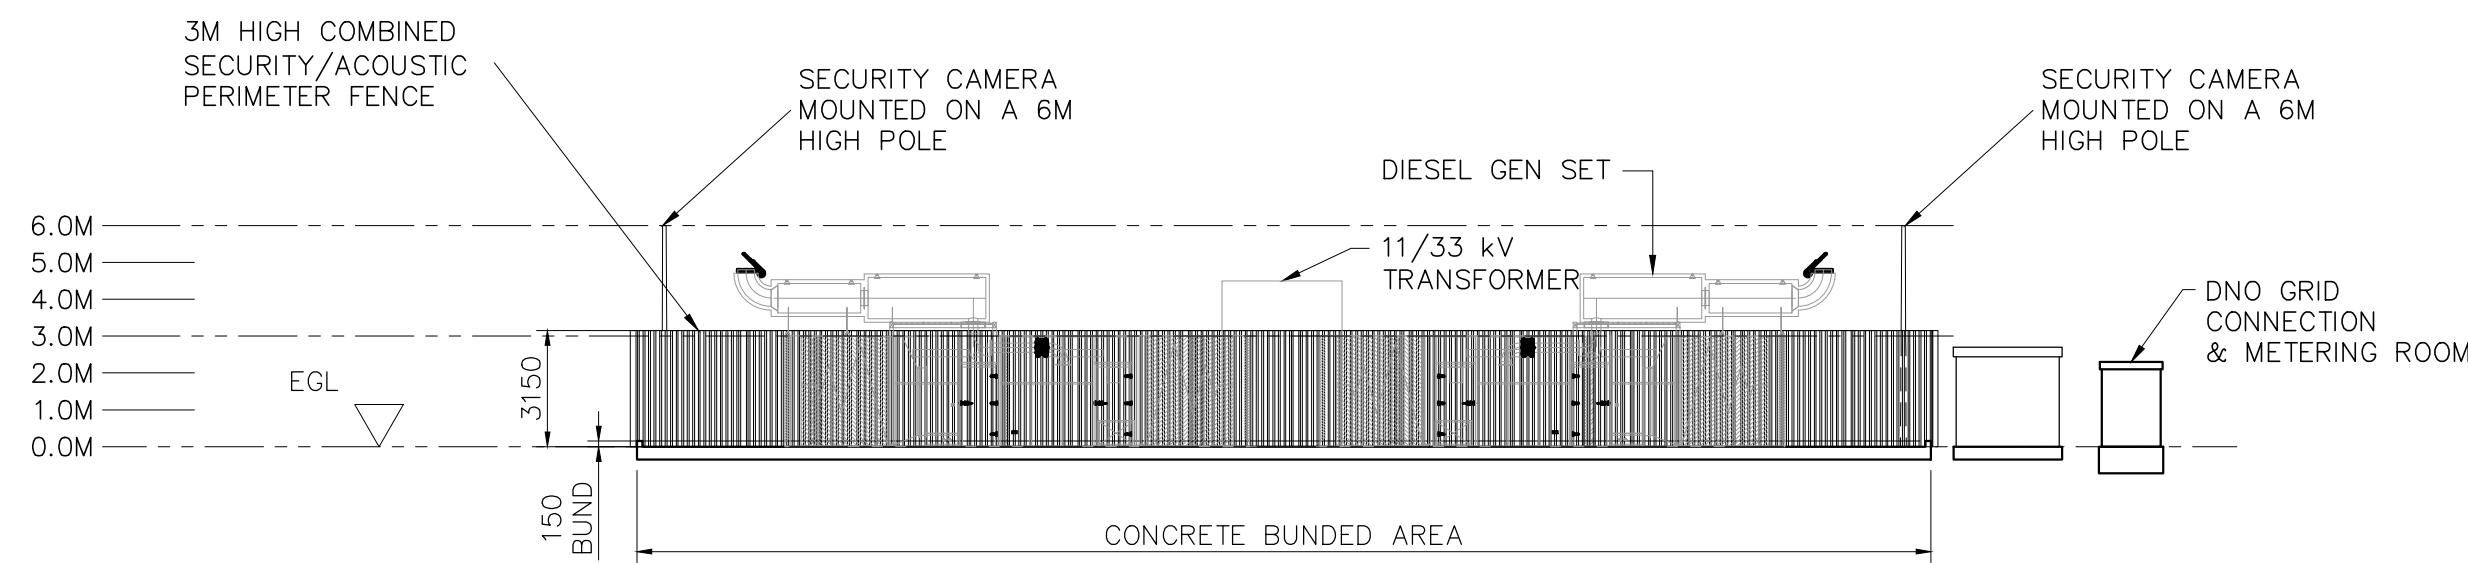

EAST ELEVATION
(SCALE 1:200)

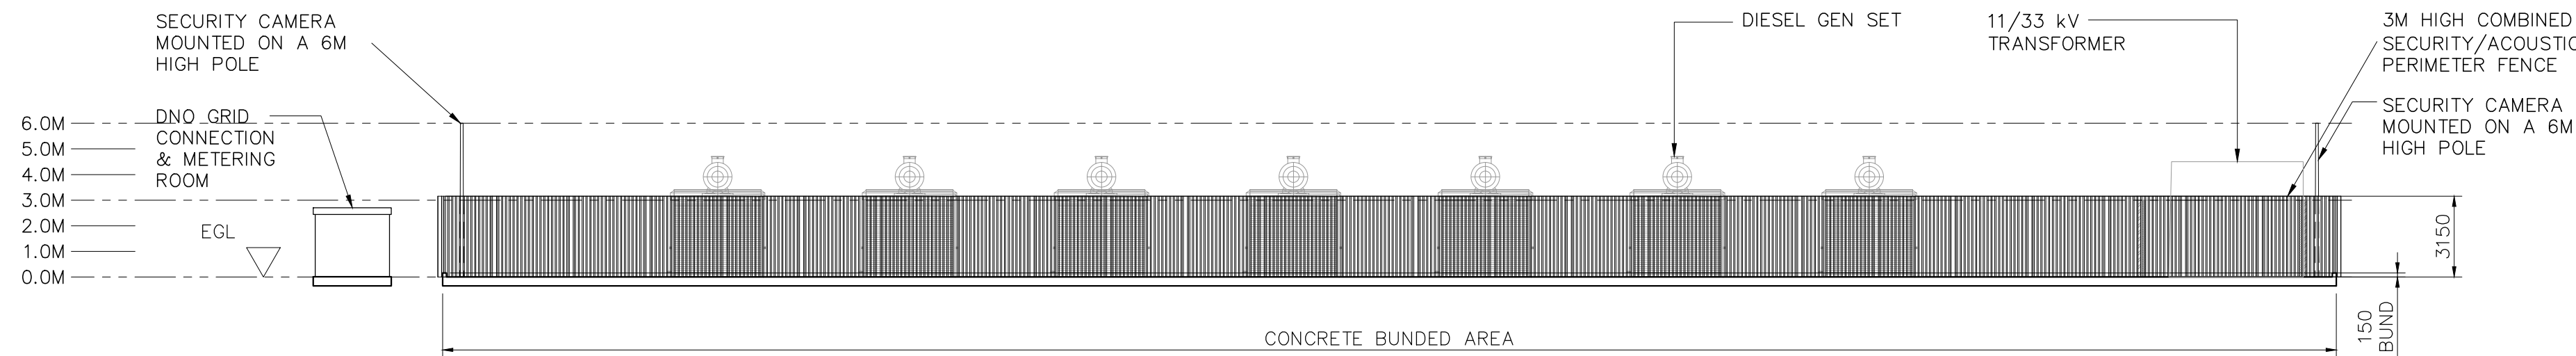


SOUTH ELEVATION
(SCALE 1:200)

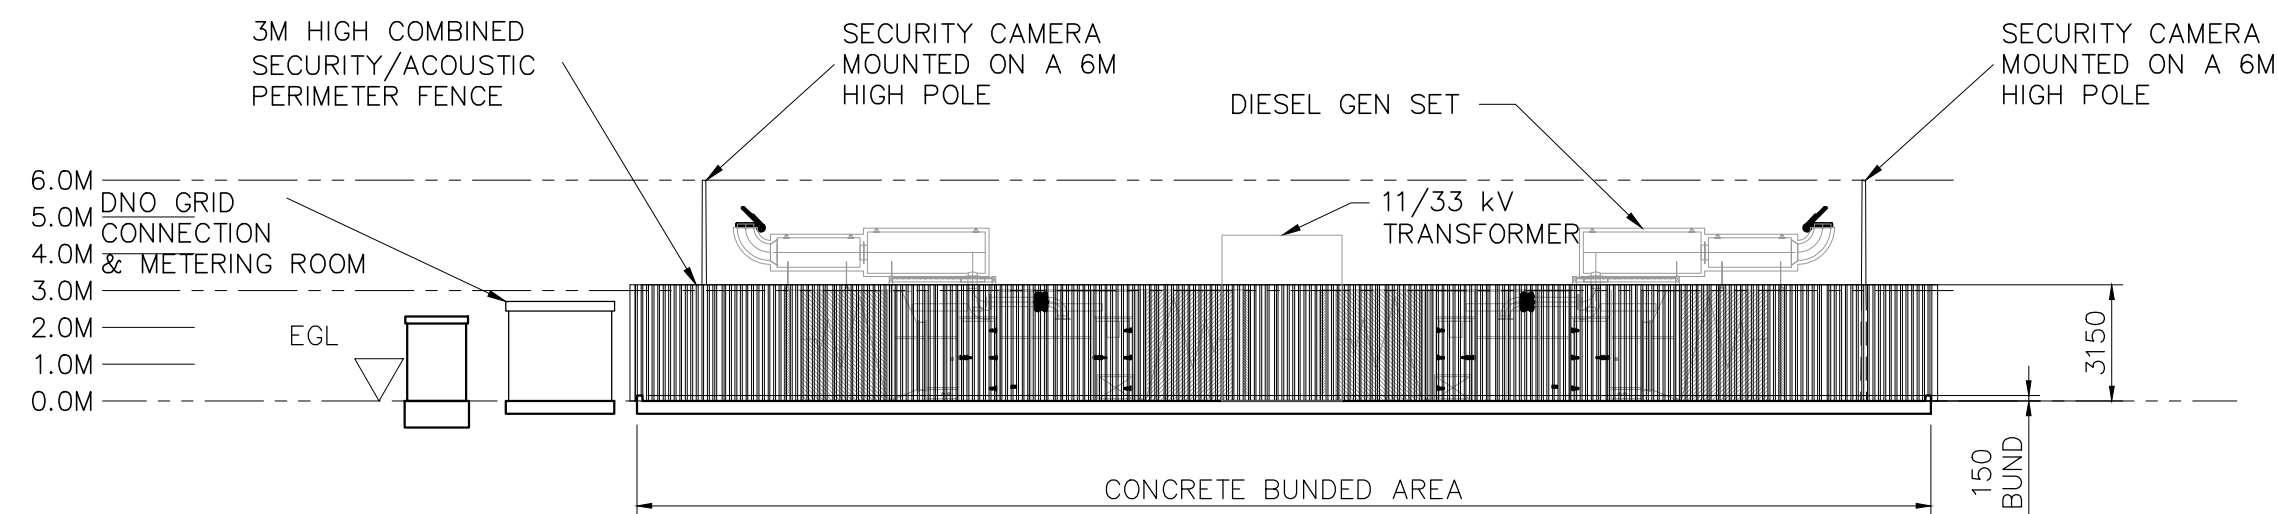

WEST ELEVATION
(SCALE 1:200)

MAXIMUM PLANT DIMENSIONS

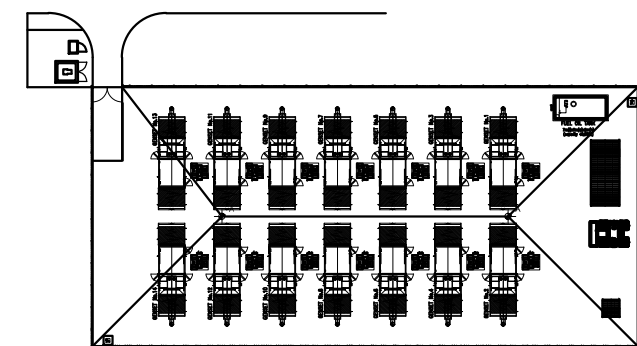

Plant Item	Max. Number	Max. Width(m)	Max. Length (m)	Max. Height (m)
Diesel Generator	14	3.6	12.8	4.7
Fuel Tanks	3	3m	7m	2.5m
0.4/11KV Transformers @ 2MVA	1 per generator	2.3	2.1	2.0
11/33KV Transformers @ 20MVA	1	3.8	5	4.5
Welfare Unit	1	2.4	2.4	2.4
Combined Control and Switchroom	1	4	9	2.3
Acoustic Screen	1	Enclosing Generating Facility site compound	Enclosing Generating Facility site compound	3



KEY PLAN
SCALE 1:1000

LEGEND

EGL EXISTING GROUND LEVEL

Rev	Date	Description	By	Chk	App
FOR PLANNING					
 Manchester Technology Centre Oxford Road Manchester M1 7ED Tel: 44-(0)161-200-5000 Fax: 44-(0)161-200-5001					
Client: 					
Site/Project: 20 MW GENERATOR INSTALLATION (14 No. GENERATORS)					
Title: ELEVATIONS					
Drawn: RS		Checked: PK			
Designed: RS		Approved: PK			
Date: 14/08/2015	Scale: 1:200	A1	Sheet: 1 OF 1	Revision:	
Project Number: 3514406A		Drawing Number: CVS-C-101		Revision: 01	
© Copyright WSP Parsons Brinckerhoff					