




11kV SUBSTATION BUILDING
FRONT ELEVATION
(SCALE 1:100)

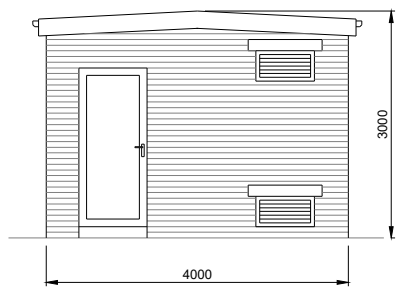


11kV SUBSTATION BUILDING
RIGHT SIDE ELEVATION
(SCALE 1:100)

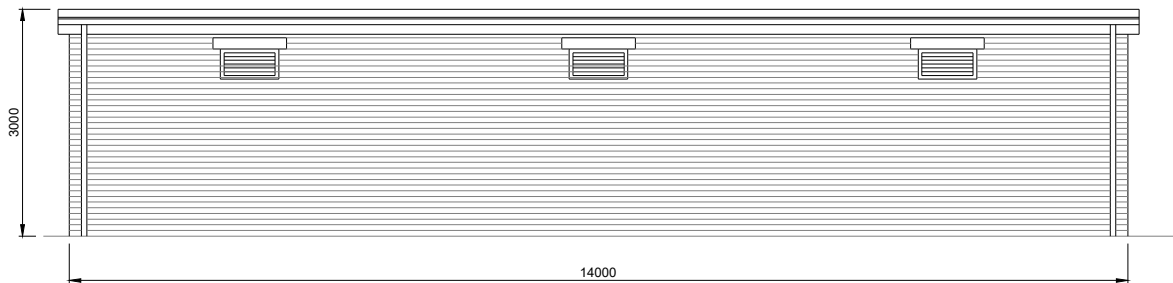


11kV SUBSTATION BUILDING
REAR ELEVATION
(SCALE 1:100)

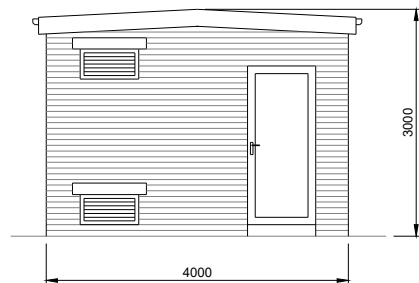


11kV SUBSTATION BUILDING
LEFT SIDE ELEVATION
(SCALE 1:100)

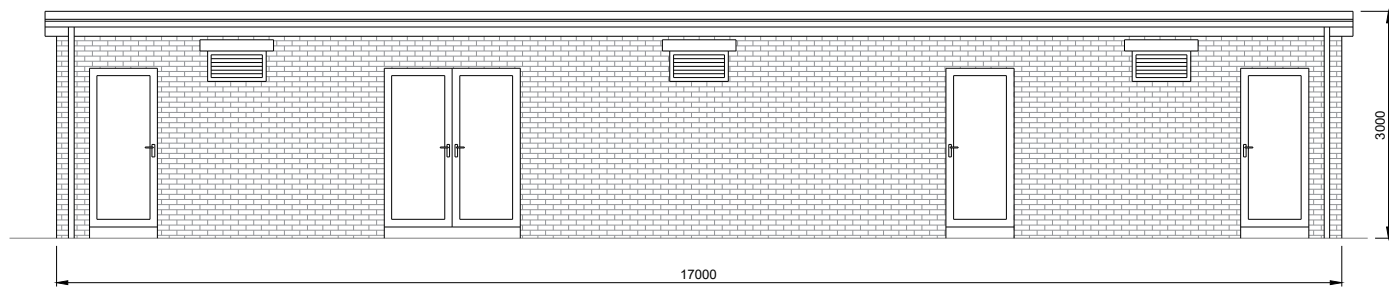


ANCILLARY BUILDING
FRONT ELEVATION
(SCALE 1:100)

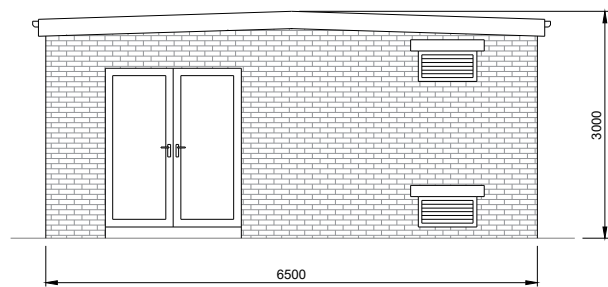


ANCILLARY BUILDING
RIGHT SIDE ELEVATION
(SCALE 1:100)

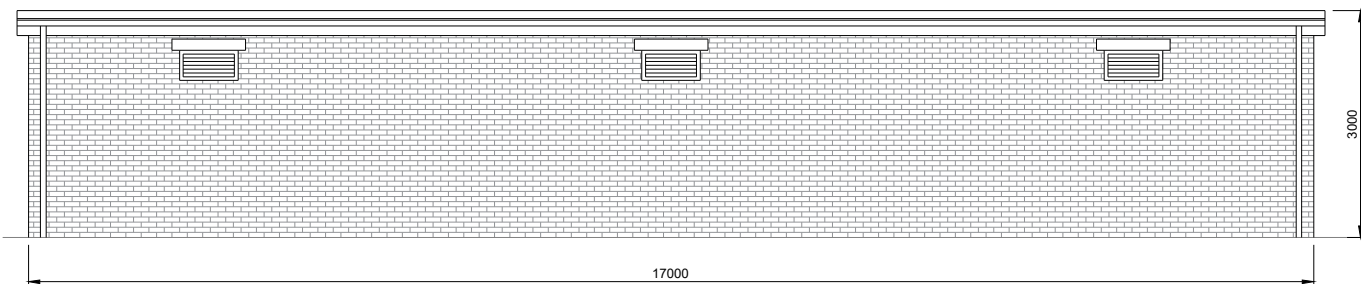

ANCILLARY BUILDING
REAR ELEVATION
(SCALE 1:100)

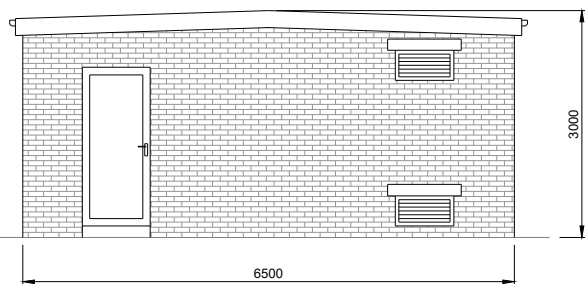

ANCILLARY BUILDING
LEFT SIDE ELEVATION
(SCALE 1:100)

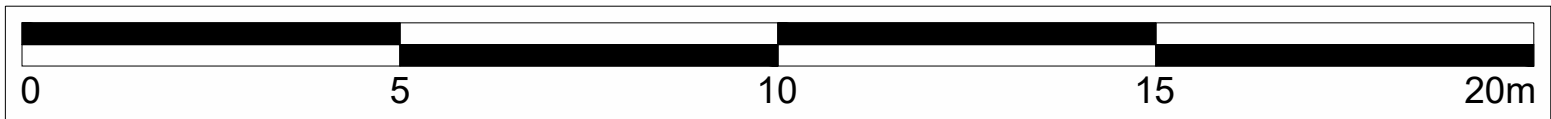

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Revision History Date

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0844 8700 007		www.axisped.co.uk		
client: KRONOSPAN				
project: KRONOSPAN NORTH ACCESS ROAD				
drawing title: PROPOSED 132kV SUBSTATION - BUILDING ELEVATIONS				
date: DECEMBER 2022		drawn by:	checked:	
drawing number: PLANNING DRAWING 9		SK	BC	
scale(s): 1:100 @A2		rev:		status: FOR PLANNING

planning environment design				