


Notes

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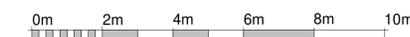
Proposed Roof Plan
1 : 100

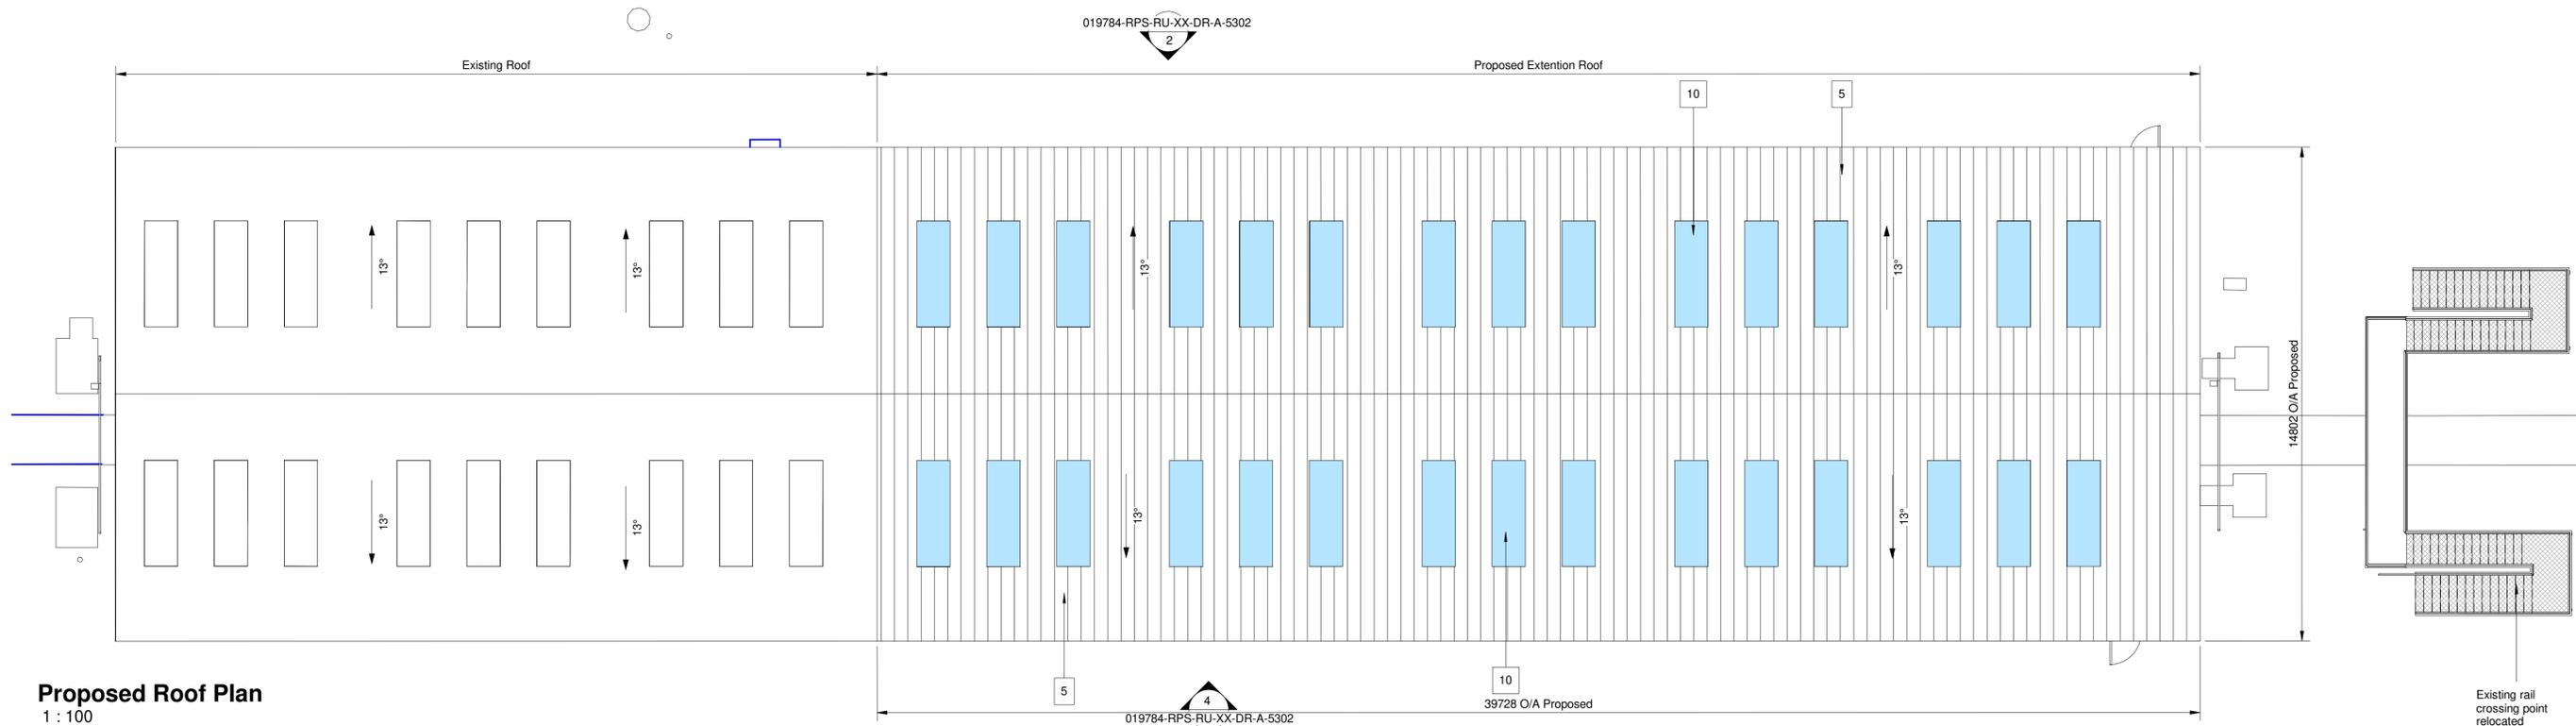

Proposed Site Key Plan,
1 : 500

KEY:

1. Built up cladding system. Vertically laid Trapezoidal wall profile. Colour: Dark Grey.
2. Built up cladding system. Vertically laid Trapezoidal wall profile. Colour: Medium Grey.
3. Built up cladding system. Vertically laid Trapezoidal wall profile. Colour: Light Grey.
4. Built up cladding system to buildings. Vertically laid Trapezoidal wall profile. Colour: Medium Grey.
5. Built up roof system to buildings. Trapezoidal profile. Colour: Light Grey
6. Single sheet roof system to conveyors. Trapezoidal profile. Colour: Light Grey
7. Single sheet cladding system to conveyors. Vertically laid Trapezoidal profile. Colour: Light Grey
8. Single sheet roof system to conveyor towers. Trapezoidal profile Colour: Medium Grey.
9. Single sheet cladding system to conveyor towers. Vertically laid Trapezoidal profile Colour: Medium Grey
10. Integrated GRP Rooflights, profile to match roof finish
11. Steel PPC Roller Shutter Door. Colour: Dark Grey
12. Steel PPC Personnel Door. Colour: Dark Grey
13. Silo



VISUAL SCALE 1:100 @ A1

P03	Drawing revised and updated to reflect new topographical survey issued, model resized to suite new layout	PBR	TFH	12/09/19
P02	Drawing revised and updated to show material finishes	PBR	TFH	01/08/19
P01	Initial Issue	PBR	NB	28/06/19
Rev	Description	By	Ckd	Date



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Client



Project **Simec Uskmouth Power Station Conversion SUP**

Title **Proposed Rail Unloading Roof Plan**

Status **Preliminary** Scale @ A1 **As indicated** Date Created **06/13/19**
Task Team Manager **TFH** Information Author **PBR** Task Information Manager **NB**

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Project Code - Originator - Zone - Level - Type - Role - Drawing Number
RPS Project Number **NK019784** Suitability **S0** Revision **P03**
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