




Zone 3 - Internal Yard Northern Elevation  
Scale @ 1 : 500

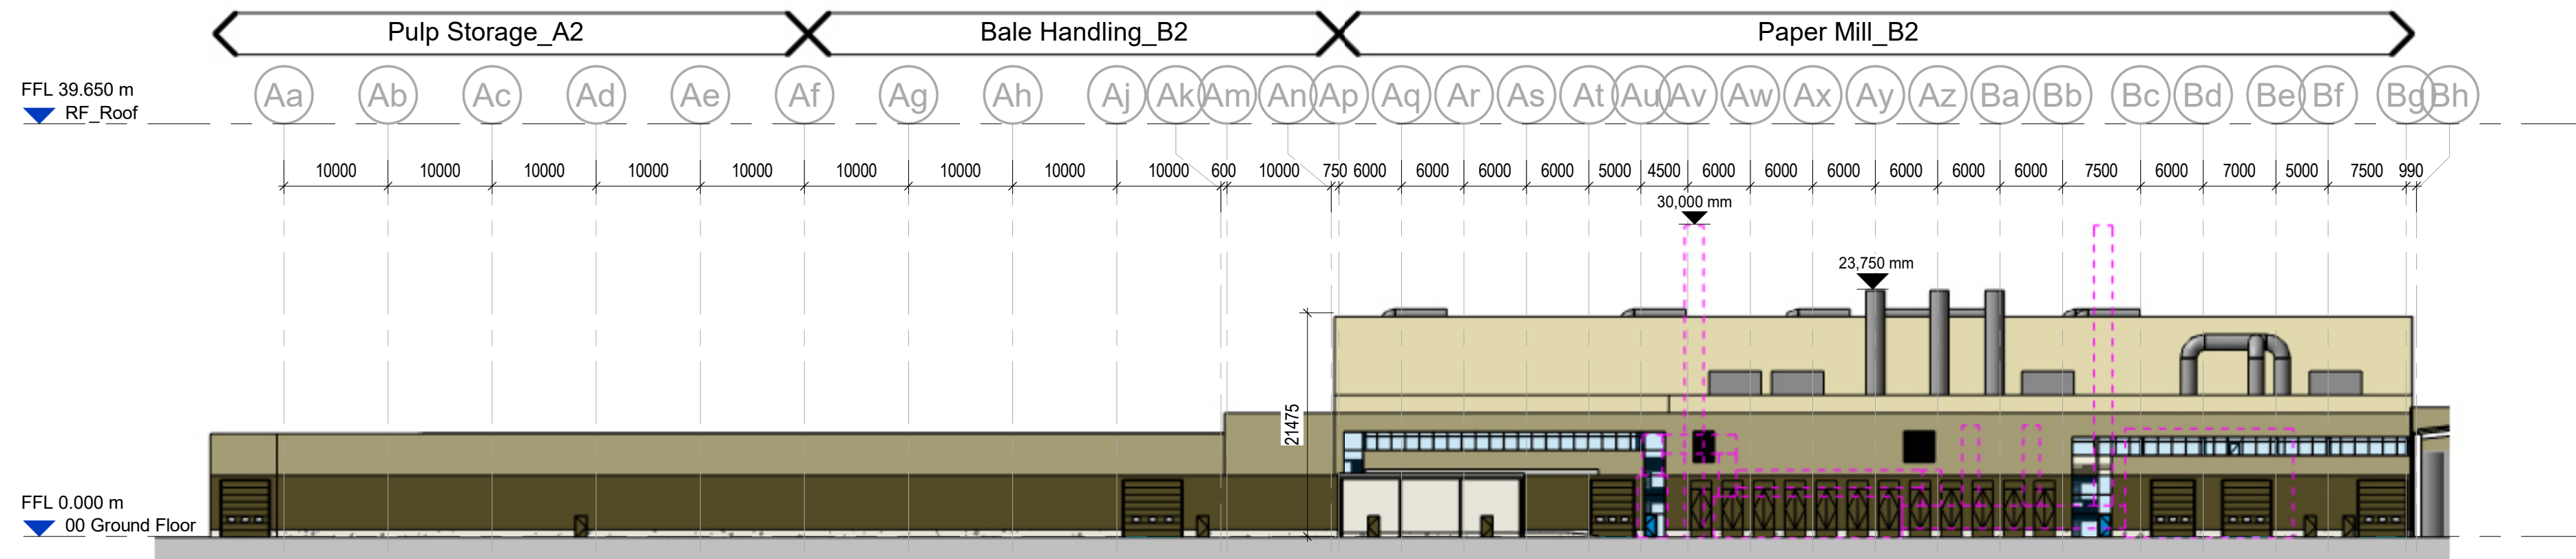


Zone 3 - Internal Yard Southern Elevation  
Scale @ 1 : 500

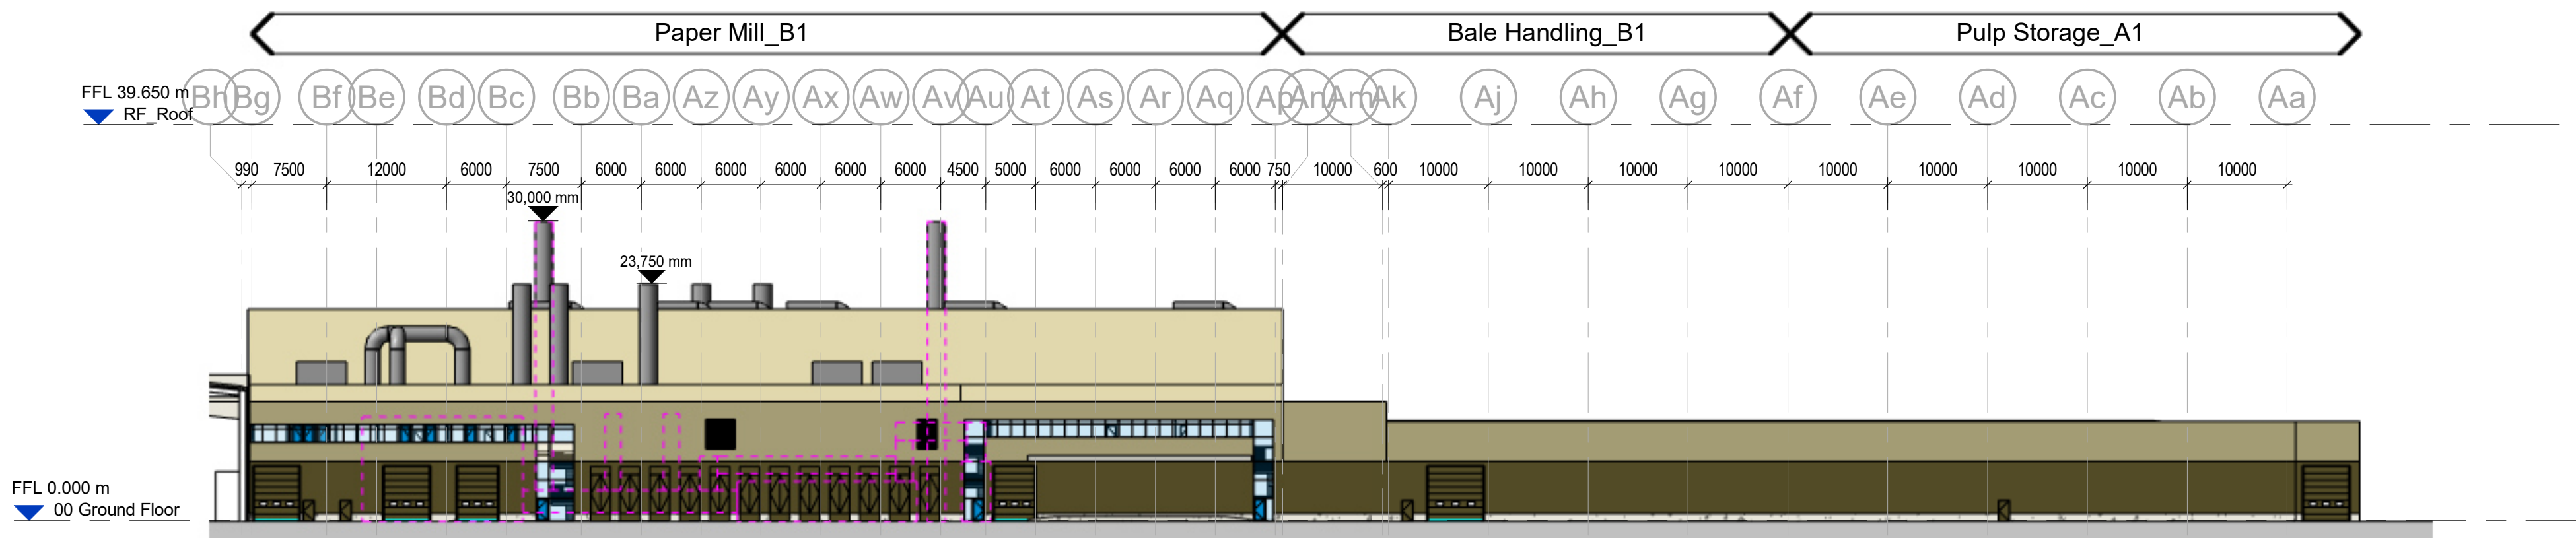


Zone 3 - North Elevation  
Scale @ 1 : 500

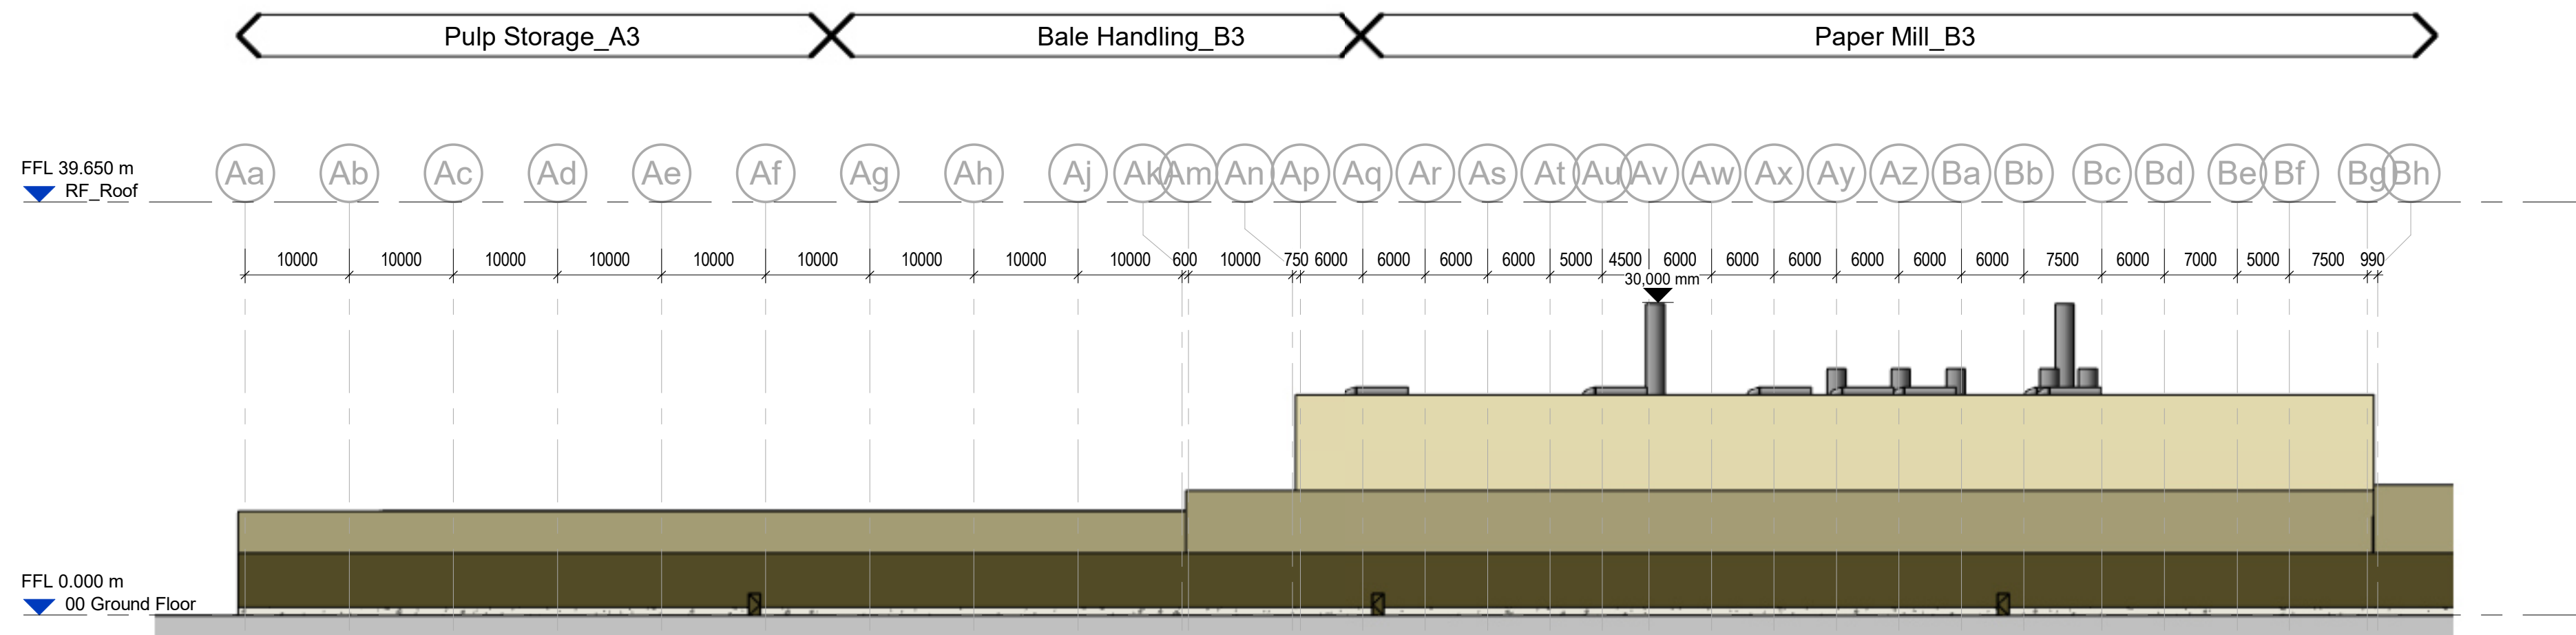

Zone 3 - South Elevation  
Scale @ 1 : 500

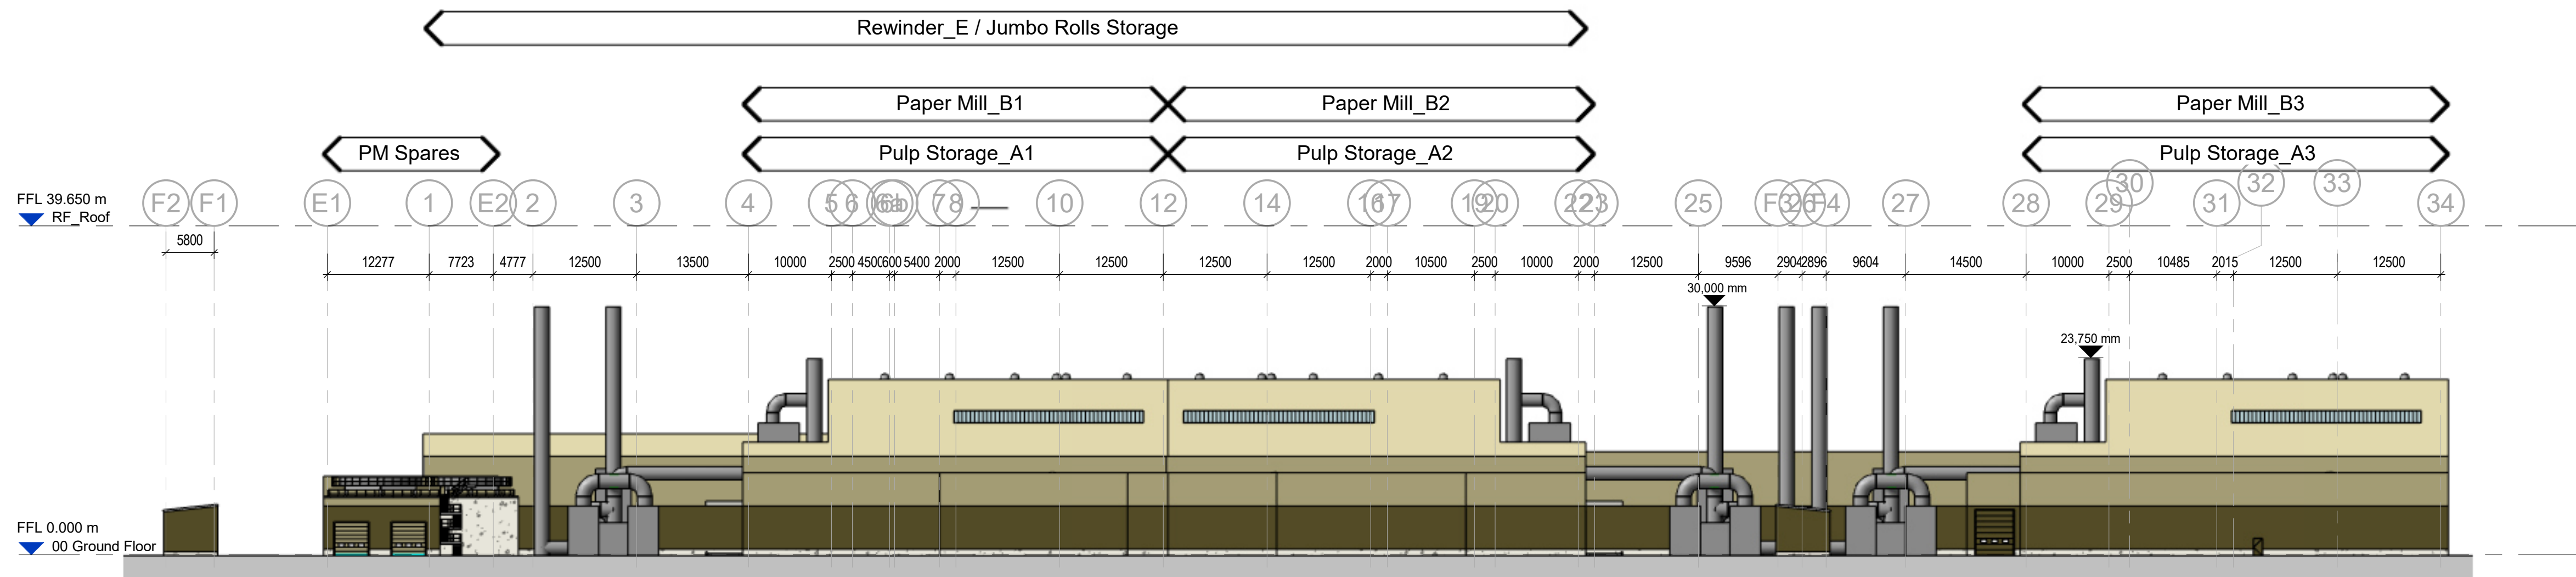

Zone 3 - West Elevation  
Scale @ 1 : 500

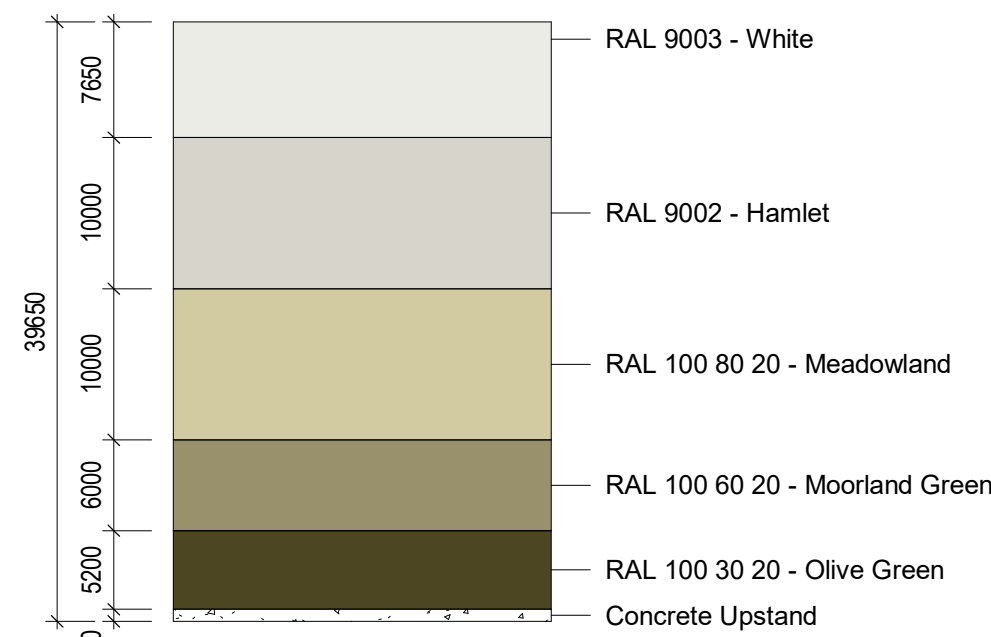

Cladding Legend  
Scale @ 1 : 500

**BUILDING FABRIC - MATERIALS SYSTEM SCHEDULE**

1. Profiled Built-up metal 'Roof Cladding' over-purlin system
2. Single sheet external canopy
3. GRP Rooflights, proprietary non-fragile and in-plane & triple skinned
4. Roof Gutters, proprietary insulated & membrane lined
5. Profiled Built-up metal 'Wall Cladding' vertically laid system
6. PPC Aluminium 'Parapet Coping' flashing
7. PPC Aluminium 'Base Drip' flashing
8. Concrete Wall Plinth

**BUILDING FABRIC - MATERIALS COMPONENT SCHEDULE**

- |   |   |
|---|---|
| A | PPC Aluminium - Window system with solar control double glazed infill units & look-a-like spandrels |
| B | PPC Aluminium - Door system with solar control double glazed infill units                           |
| C | Translucent Wall Panels   |
| D | PPC Galvanised Steel - Personnel Access (Escape) & PM Facade Doorset                                |
| E | Sectional Insulated Shutter   |
| F | External Louvre   |
| G | Exhaust Stack/Roof Ventilators (final locations TBC)  |
| H | Indicative External Plant to ICT requirements   |

Scale Bars			
TO BE USED ONLY AS GUIDANCE			
1:500	mm	1:1000	mm
1:2500	m	1:5000	m
1:10000	m	1:25000	m
1:100000	m	1:250000	m

**NOTES**

- All dimensions and levels are to be checked on site.
  - Any discrepancies are to be reported to the architect before any work commences.
  - This drawing shall not be scaled to ascertain any dimensions. Work to figured dimensions only.
  - This drawing shall not be reproduced without express written permission from AEW.
  - Title overlay drawings and ownership boundaries are produced using all reasonable endeavors. AEW cannot be responsible for the accuracy or scale discrepancy of base plans supplied to them.
  - All works are to be undertaken in accordance with Building Regulations and the latest British Standards.
  - All proprietary materials and products are to be used strictly in accordance with the manufacturers recommendations.
- This drawing contains the following model files: -  
12500-AEW-B1-XX-M3-A-0001

**CDM 2015**

Client notified of duties: **YES**  
Principal Designer: **ICT**

Unless noted below, all known hazards have been highlighted on the drawing.

Rev	Date	Description	Drawn By	Checked By
R02	20/09/21	ISSUED FOR APPROVAL	MB	DOH
P01	21/08/21	Initial Issue	TF	DOH

Status: S2 Purpose of Issue: For Approval

drawing stage: Stage 3

client: ICT

project: ICT Paper Mill Deeside

drawing title: Process Zone 3 - Proposed GA Elevations

date: 08/02/21 drawn: TF

scale: As indicated checked: DOH

Rev P02

12500-AEW-B1-XX-DR-A-0563

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